

WEDDINGTON TOWN CENTER



ODA Architecture

2010 South Tryon St., Suite 1a Charlotte, NC, 28203 704.332.1615 www.oda.us.com

SEAL:

PROGRESS PRINT NOT FOR CONSTRUCTION

CONSULTANT:

POLIVKA OFFICE PARK

13700 PROVIDENCE RD. WEDDINGTON, NORTH CAROLINA ODA PROJECT # 233726

ZONING APPROVAL

REVISIONS


No. Description Date

SURROUNDING CONTEXT

CZ-001

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ODA Architectu

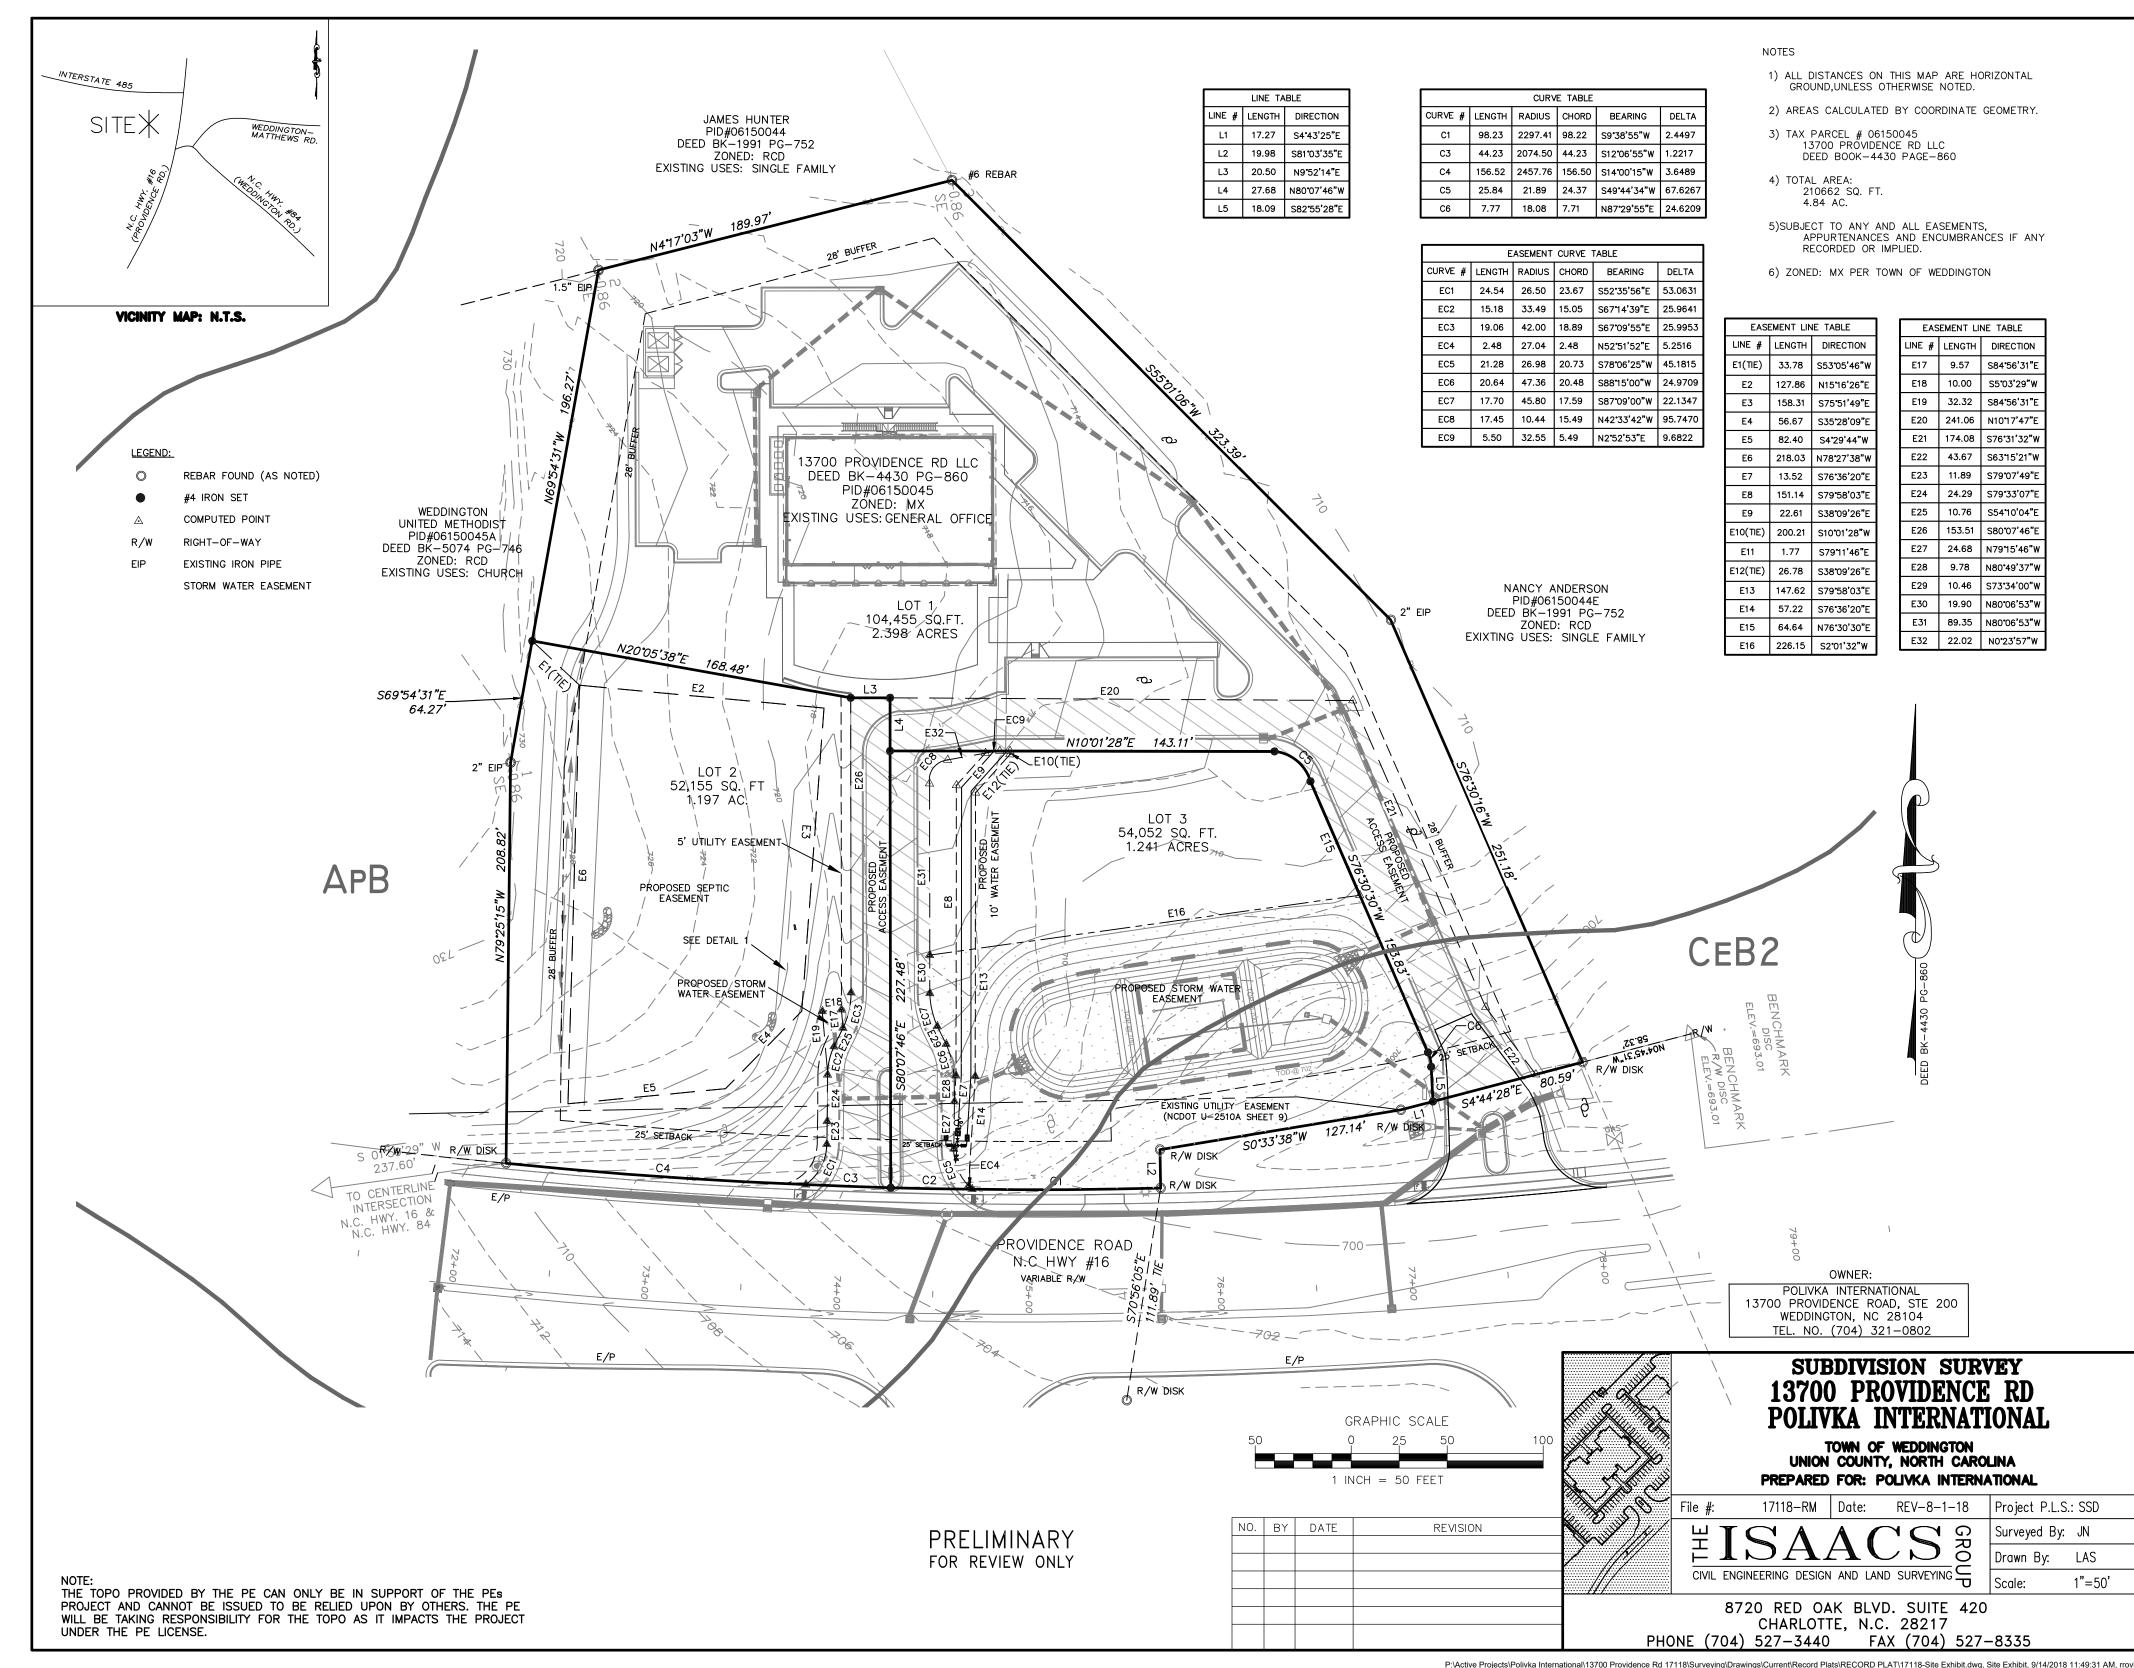

October 9, 2024

Town of Weddington Attn: Planning Board 1924 Weddington Road Weddington, NC 28104

Re: 13700 Providence Road

Matthews, NC

DPR Project #: 24065



To whom it may concern:

A preliminary engineering analysis was performed for the project site located at 13700 Providence Road in Matthews, North Carolina. This analysis allowed us to determine the necessary improvements that would need to be made to the existing stormwater control measure in order to accommodate the proposed increase in built-upon-area (BUA).

Per the Conditional Rezoning Architectural Site Plan prepared by ODA Architecture, approximately 0.70 acres of new impervious area is proposed. The existing stormwater for this site is managed by a dry detention basin and surface sand filter to provide both quantity and quality controls.

In order to accommodate the proposed 0.70 acres of increased BUA, the following modifications to the existing dry detention basin and surface sand filter are proposed:

- Increase volume of current dry detention from 32,000 ft³ to 55,000 ft³ by providing a two ft. wall on the southern side of the basin and raising the top of the basin from 702.00 to 704.00.
- Minor modifications to the existing outlet control structure (rim elevation, orifices, weirs) and sand media will be required. This will be fully designed during the construction design phase and permitting with the Town of Weddington.

The proposed modifications meet the current Town of Weddington UDO requirements for stormwater management, including providing detention volume control up to the 100-year, 24-hour storm event.

Sincerely,

Skylar DeMatteis, PE Civil Project Manager DPR Design sdematteis@dpr.design (330)-844-0306



General Notes

1. The owner acknowledges that other standard development requirements imposed by other city ordinances, standards, policies, and appropriate design manuals will exist. Conditions set forth in this petition are supplemental requirements imposed on the development in addition to other standards. Where specified conditions on this plan differ from ordinances, standards, policies, and approaches in existence at the time of formal engineering plan review submission, the conditional notes on this plan shall apply.

- 2. This Site Plan is schematic in nature and represents a firm concept of development with regard to the arrangement of the building, parking and circulation patterns. Minor changes of detail which do not alter the basic layout and relationships to abutting sites are permitted as a matter of right for the petitioner / developer.
- 3. **Proposed Uses**: The use of the two new proposed buildings will be General Office and Medical Office only.
- 4. Parking Spaces: parking spaces shall be a minimum of 9' x 20'. There are 77 spaces illustrated, and allocated to the new buildings. Parking to meet UDO requirements.
- 5. Phasing: It is the intent of the developer to construct both new and proposed buildings simultaneously in on phase.
- 6. Signage: All Signage will be permitted separately 7. Building Height: The maximum building height for a
- MX Zone is 40'. As illustrated in the renderings and elevations, the height of the ridge will be a maximum of
- 8. Landscape Requirements : The petitioner understands that, as a condition of approval, the proposed development shall be subject to all landscape and buffer requirements of the Town of Weddington UDO
- 9. Sewer Allocations: The proposed development will have a Septic System with the capacity for the proposed office buildings, as designed by Piedmont Design Associates, P.A. See Sheets U-1, U-2, U-3

Polivka International

13700 Providence Road, LLC.

Existing Zoning: MX (CZ) Mixed Use Conditional Zoning District

DEED BK-4430 PG-860 PID #06150045 Lot 1, Lot 2, Lot 3

Acreage: 5.06 acres

(44,083 SF) (32,300 SF) FAR Maximum: FAR Proposed:

Site Data:


North Adjacent Land Parcel Nancy Anderson PID# 06150044E DEED BK-1991 PG-752 Zone: R-40 Existing Use: Single Family

West Adjacent Land Parcel James Hunter PID# 06150044 DEED BK-1991 PG-752 Zone: R-40Existing Use: Single Family

South Adjacent Parcel Weddington United Methodist Church PID# 06150045A DEED BK-5047 PG-746 Zone: R-40 Existing Use: Church

Proposed Uses: The proposed uses are General Office and Medical Office only.

Proposed Development Description: The Site Plan illustrates (2) two-story office buildings of 9,000 sf each. The style of the proposed structures is Georgian with similar detailing to the existing 2-story office building. The access to the site exists and will remain. New parking areas will be constructed in the general configuration illustrated on the Site Plan.

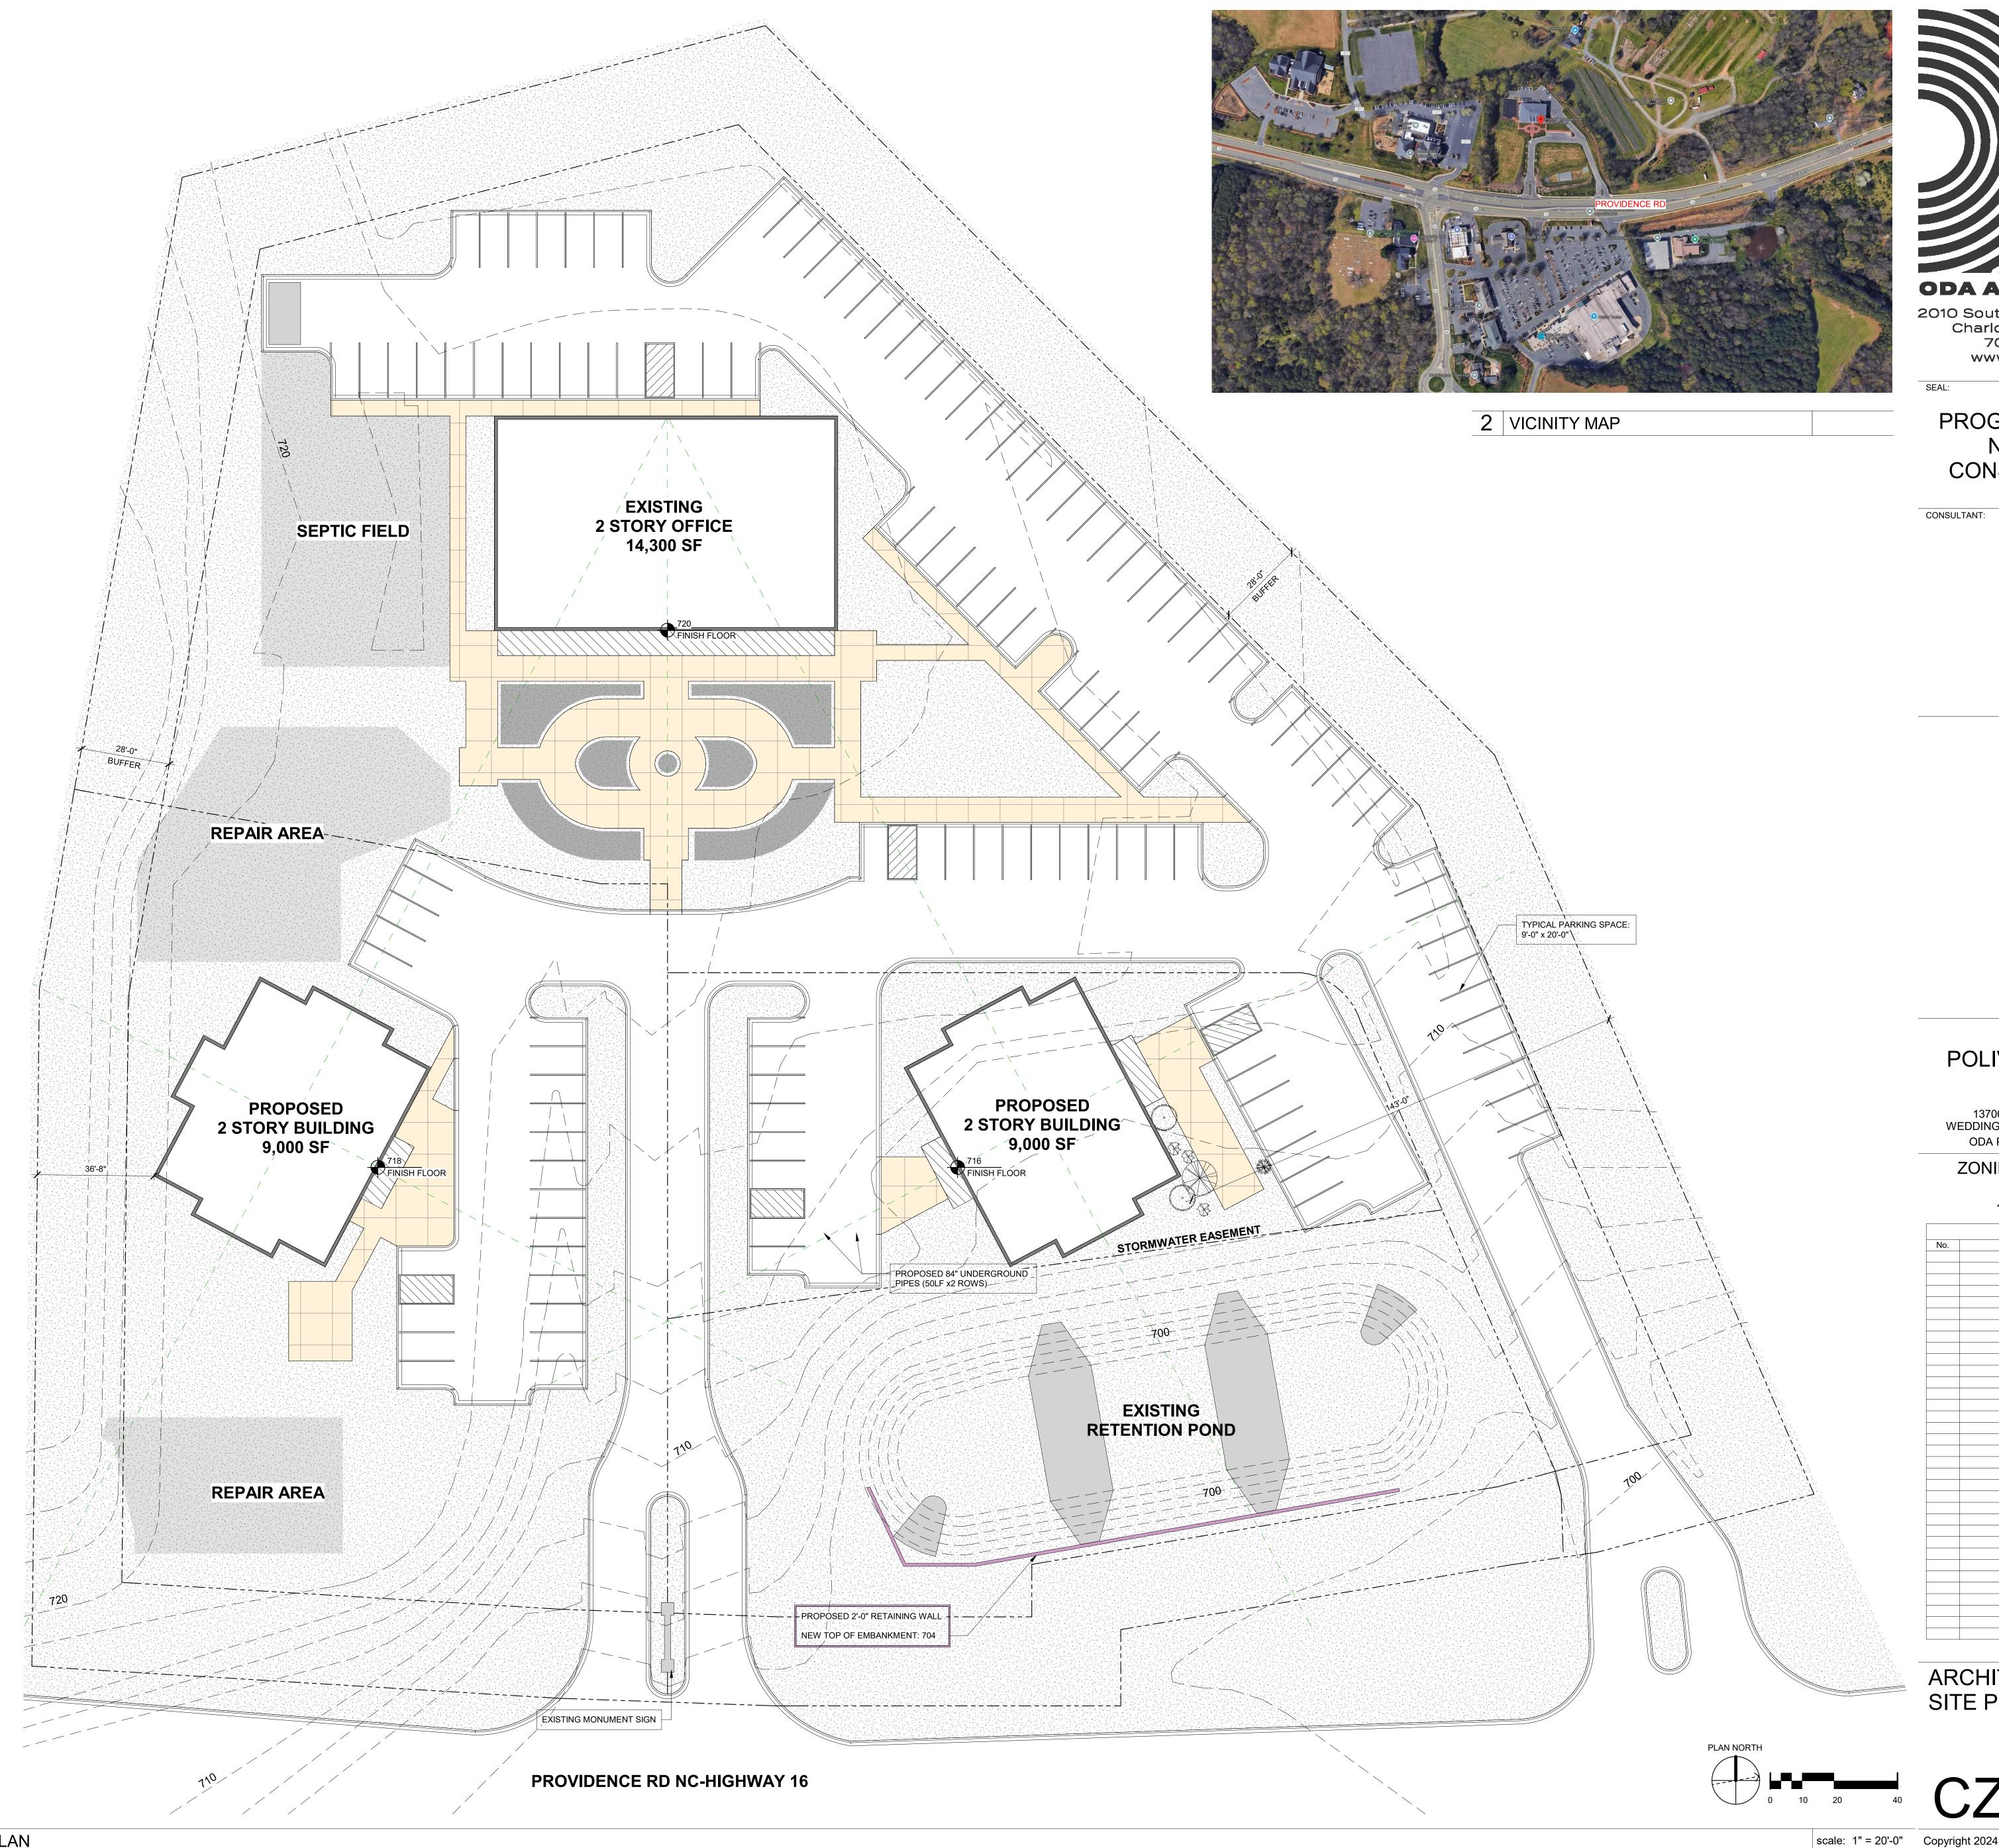



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ZONING APPROVAL

REVISIONS			
No.	Description	Date	
	•		

ARCHITECTURAL SITE PLAN

1 SITE PLAN

Tree Planting Notes

- 1. All trees and shrubs shall meet or exceed the minimum requirements as noted in Weddington Municode Section 58-8.
- 2. The contractor shall contact North Carolina One Call prior to digging.
- 3. Planting backfill mixture: 4 parts topsoil; 1 part peat moss; 10 LBS. 5-10-5 planting fertilizer throughly mixed per cubic yard.
- 4. Stake trees immediately after planting.
- 5. All disturbed areas shall be seeded and mulched. 6. All existing landscaping to remain where possible.
- Any plantings damaged during the construction process to be replaced by equal or more plantings than before.

Buffer Yard Notes

Any existing trees retained in healthy condition yard buffers may be credited for any required tree planting.
 Trees and shrubs for buffer planting to be selected

from the town of Weddington list of acceptable plant species, Chapter 18 Appendix 1.

Screening Requirements (per table 58-8)

6 Trees and 20 Shrubs per 100' Perimeter Buffer:

Open Space Requirement

220,413 SF (5.06 Acres) Total Site: 10% Open Space Required (22,041 SF) 17% Open Space Provided (38,033 SF)

KEY:

Existing Lampposts

Proposed Lampposts

New Plantings for Screening



PLANTLIST

	LANT LIST			
KEY	COMMON/ BOTANICAL NAME	SIZE		
V	TREES			
AR	ACER RUBRUM 'OCTOBER GLORY' OCTOBER GLORY RED MAPLE	2" CAL., B & B, LIMB UP TO 6'		
BN	BETULA NIGRA RIVER BIRCH	2" CAL., B & B,		
FA	ILEX X ATTENUATA 'FOSTERI' FOSTER HOLLY	2" CAL., B & B,		
LI	LAGERSTROEMIA INDICA 'NATCHEZ' NATCHEZ CRAPE MYRTLE	2" CAL., B & B,		
PY	PRUNUS YEDOENSIS YOCHINO CHERRY	2" CAL., B & B,		

	SHRUBS	
FI	FORSYTHIS INTERMEDIA SHOWY FORSYTHIA	24" MIN. HT., 4' O.C.
RU	RAPHIOLEPSIS UMBELLATA YEDDO-HAWTHORN	36" HT., 4' O.C.
LL	LIGUSTRUM LUCIDUM GLOSSY PRIVET	36" HT., 5' O.C.

BMP PLANTING

BETULA NIGRA RIVER BIRCH	8' HT., B&B	
LAGERSTROEMIA INDICA 'NATCHEZ' NATCHEZ CRAPE MYRTLE	6' HT., B&B	
MAGNOLIA 'LITTLE GEM' LITTLE GEM MAGNOLIA	5' HT., B&B.	
ILEX CRENATA COMPACTA COMPACTA HOLLY	24" HT., 4' O.C.	
NSIDE BMP SAND FILTER PLANTS:		
RIVER OATS Chasmanthium latifolium	2FT OC	2"DIA X 5"PLUG
JOE PYE WEED Eupatoriadelphus fistulosus	2 FT OC	2"DIA X 5"PLUG
LITTLE BLUESTEM Schizachyrium scoparium	1.5 FT OC	2"DIA X 5"PLUG
	RIVER BIRCH LAGERSTROEMIA INDICA 'NATCHEZ' NATCHEZ CRAPE MYRTLE MAGNOLIA 'LITTLE GEM' LITTLE GEM MAGNOLIA ILEX CRENATA COMPACTA COMPACTA HOLLY NSIDE BMP SAND FILTER PLANTS: RIVER OATS Chasmanthium latifolium JOE PYE WEED Eupatoriadelphus fistulosus	RIVER BIRCH LAGERSTROEMIA INDICA 'NATCHEZ' NATCHEZ CRAPE MYRTLE MAGNOLIA 'LITTLE GEM' LITTLE GEM MAGNOLIA ILEX CRENATA COMPACTA COMPACTA HOLLY NSIDE BMP SAND FILTER PLANTS: RIVER OATS Chasmanthium latifolium JOE PYE WEED 2 FT

ADDITIONAL PLANTING (PARKING AREAS, BLDG FOUNDATION)

IC	ILEX CORNUTA 'CARISSA' CARISSA HOLLY	24"HT., 3' O.C.
ND	NANDINA DOMESTICA 'GULFSTREAM' GULFSTREAM NANDINA	15" HT., 24" O.C.
ТВ	ILEX CORNUTA BURFORDI	LIMBIED UP TREE FORM,





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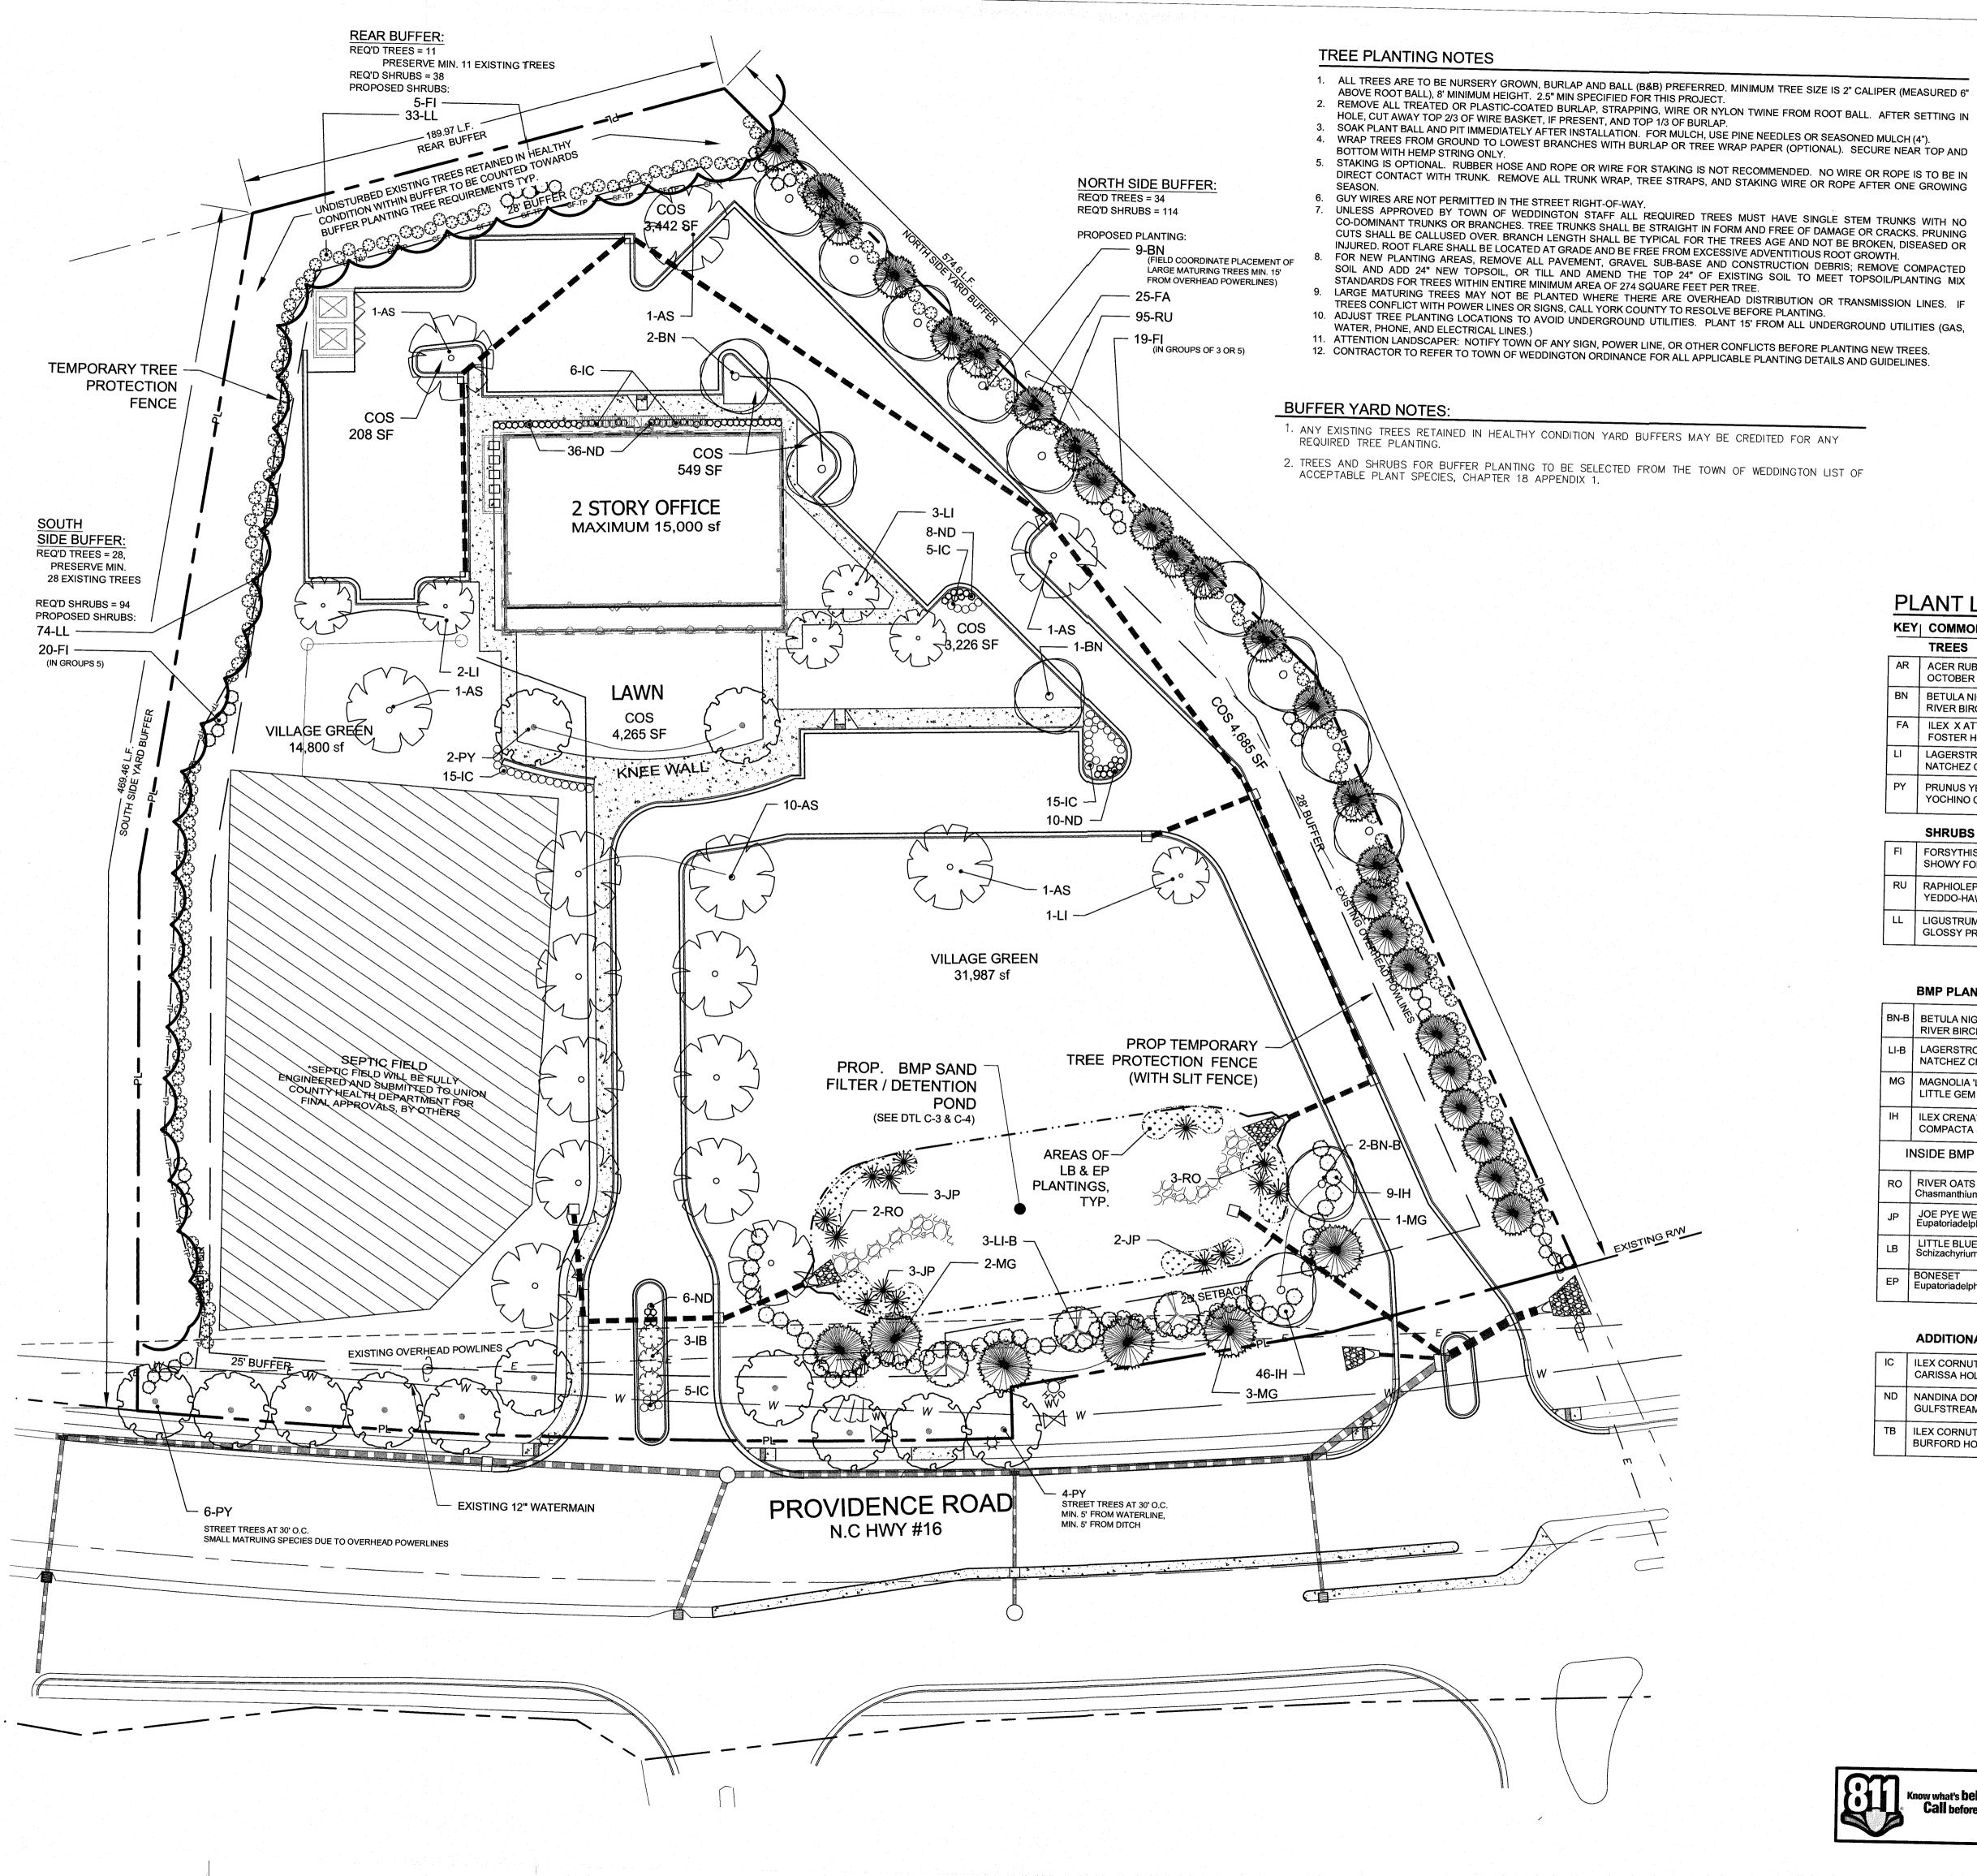
	REVISIONS		
No.	Description	Date	

LANDSCAPE AND SITE LIGHTING PLAN

1 SITE PLAN

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ODA Architecture





landscape architecture civil engineering

DPR Associates, Inc. I 420 Hawthorne Lane I Charlotte, NC 28204 ph. 704.332.1204 l fx. 704.332.1210 l www.dprassociates.net

TOTAL SITE: 220,413 S.F. (5.06 ACRES) 10% OPEN SPACE REQUIRED: 22,041 S.F.. 63,162 S.F. PROVIDED

Screening Requirements (per table 58-8) Perimeter Buffer: 6 Trees and 20 Shrubs per 100'

LANDSCAPING NOTES

- 1. ALL TREES AND SHRUBS SHALL MEET OR EXCEED THE MINIMUM REQUIREMENTS AS NOTED IN WEDDINGTON MUNICODE SECTION 58-8.
- 2. THE CONTRACTOR SHALL CONTACT NORTH CAROLINA ONE CALL PRIOR TO DIGGING.
- 3. PLANTING BACKFILL MIXTURE: 4 PARTS TOPSOIL; 1 PART PEAT MOSS; 10 LBS. 5-10-5 PLANTING FERTILIZER
- 4. STAKE TREES IMMEDIATELY AFTER PLANTING.

THOROUGHLY MIXED PER CUBIC YARD.

5. ALL DISTURBED AREAS SHALL BE SEEDED AND MULCHED.

PLANT LIST

KEY	COMMON/ BOTANICAL NAME	QTY.	SIZE
	TREES		
AR	ACER RUBRUM 'OCTOBER GLORY' OCTOBER GLORY RED MAPLE	15	2" CAL., B & B, LIMB UP TO 6'
BN	BETULA NIGRA RIVER BIRCH	12	2" CAL., B & B,
FA	ILEX X ATTENUATA 'FOSTERI' FOSTER HOLLY	25	2" CAL., B & B,
LI	LAGERSTROEMIA INDICA 'NATCHEZ' NATCHEZ CRAPE MYRTLE	6	2" CAL., B & B,
PY	PRUNUS YEDOENSIS YOCHINO CHERRY	12	2" CAL., B & B,
		1	

SHRUBS


FI	FORSYTHIS INTERMEDIA SHOWY FORSYTHIA	44	24" MIN. HT., 4' O.C.
RU	RAPHIOLEPSIS UMBELLATA YEDDO-HAWTHORN	95	36" HT., 4' O.C.
LL	LIGUSTRUM LUCIDUM GLOSSY PRIVET	107	36" HT., 5' O.C.


BMP PLANTING

	BIMP PLANTING			
BN-B	BETULA NIGRA RIVER BIRCH	2	8' HT., B&	В
LI-B	LAGERSTROEMIA INDICA 'NATCHEZ' NATCHEZ CRAPE MYRTLE	3	6' HT., B&	В
MG	MAGNOLIA 'LITTLE GEM' LITTLE GEM MAGNOLIA	6	5' HT., B&I	В.
IH	ILEX CRENATA COMPACTA COMPACTA HOLLY	55	24" HT., 4'	O.C.
ļļ	NSIDE BMP SAND FILTER PLANTS:	Į		
RO	RIVER OATS Chasmanthium latifolium	5	2FT OC	2"DIA X 5"PLUG
JP	JOE PYE WEED Eupatoriadelphus fistulosus	9	2 FT OC	2"DIA X 5"PLUG
LB	LITTLE BLUESTEM Schizachyrium scoparium	200	1.5 FT OC	2"DIA X 5"PLUG
EP	BONESET Eupatoriadelphus perfoliatum	200	1.5 FT OC	#SP4 CG

ADDITIONAL PLANTING (PARKING AREAS, BLDG FOUNDATION)

IC	ILEX CORNUTA 'CARISSA' CARISSA HOLLY	46	24"HT., 3' O.C.
ND	NANDINA DOMESTICA 'GULFSTREAM' GULFSTREAM NANDINA	60	15" HIT., 24" O.C.
ТВ	ILEX CORNUTA BURFORDI BURFORD HOLLY	3	LIMBIED UP TREE FORM, 4' HT.

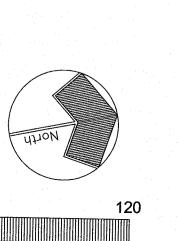

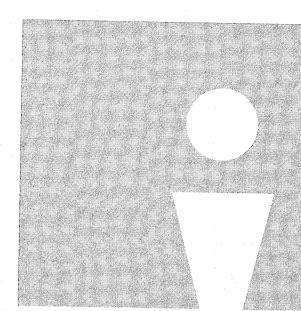

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5-10-13 5-10-13 3-27-13


PLANTIN. **COMMON OPEN SPACE** PLAN

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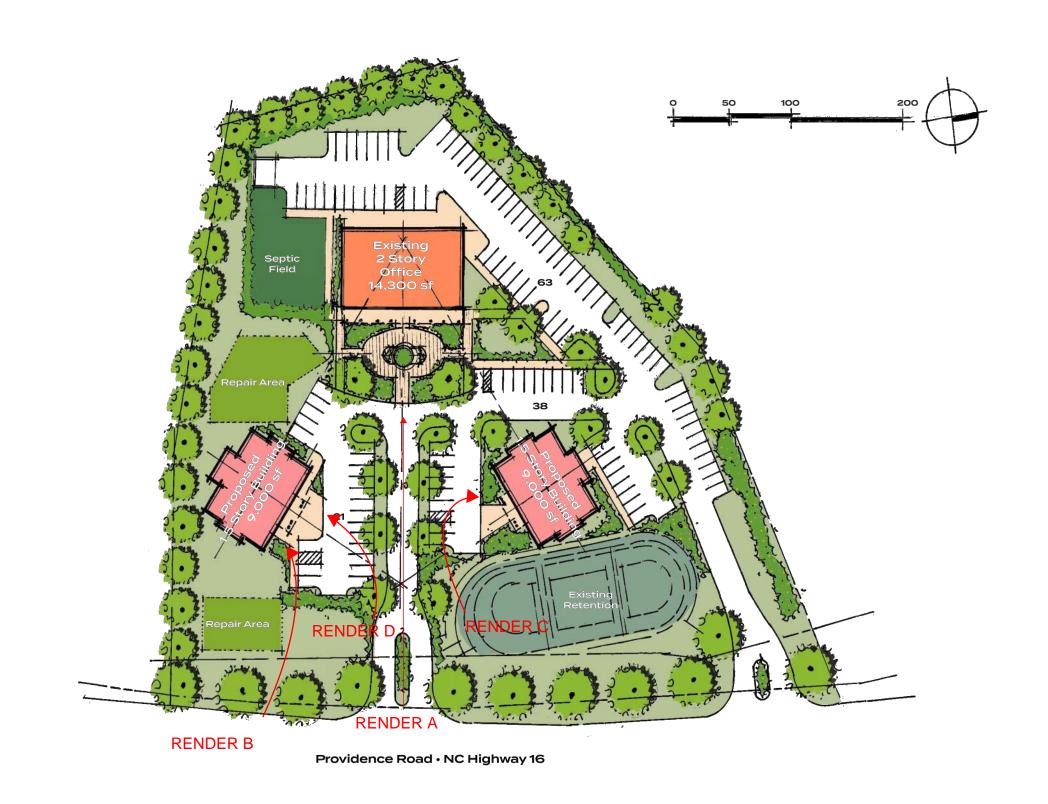






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10.09.2024

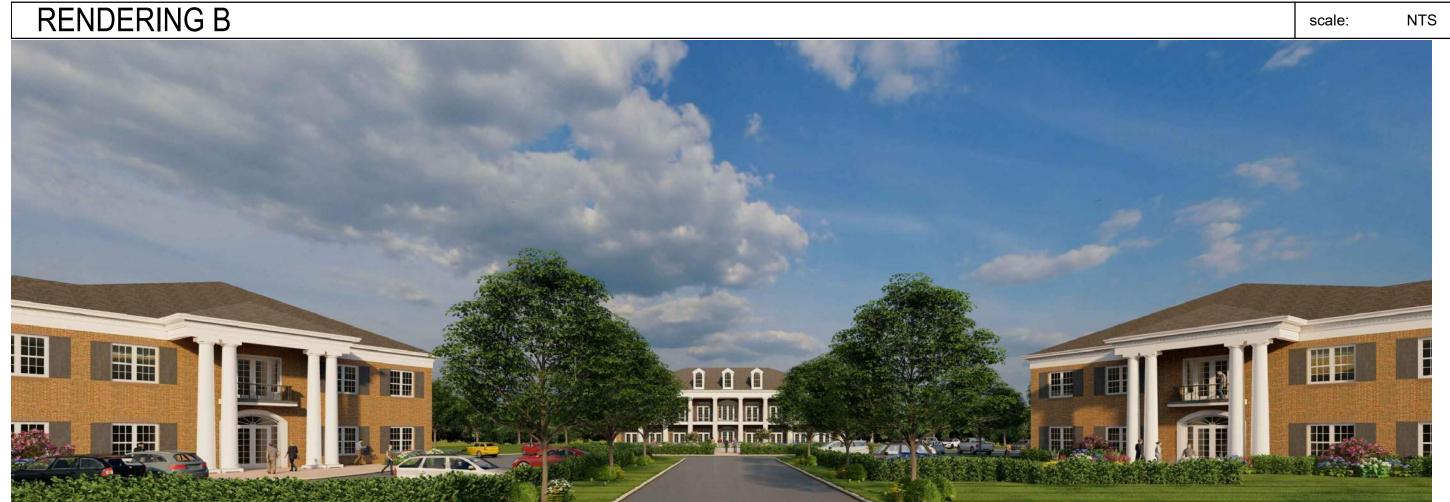REVISIONS

ZONING APPROVAL



BUILDING ELEVATION - EAST scale: 1/16" = 1'-0"



RENDERINGS AND DETAILS

2 RENDERING A

scale:

BUILDING ELEVATION - SOUTH

KEY PLAN

scale: 1/16" = 1'-0" Copyright 2024

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SOIL SCIENTIST: SOIL & ENVIRONMENTAL CONSULTANTS, PA 8412 FALLS OF NEUSE ROAD RALEIGH, NC 27615 DON WELLS, LSS (919) 846-5900

SURVEYOR: THE ISAACS GROUP 8720 RED OAK BLVD # 420 CHARLOTTE, NC 28217 STEVE DYER, PLS (704) 527-3440


LICENSE NO: 1099


SEPTIC CONTRACTOR: AQWA 2604 WILLIS COURT WILSON, NC 27896 (252) 243-7693

LICENSE NO: 57240

LICENSE NO: L-3509

PROPERTY OWNER: POLIVKA INTERNATIONAL 13700 PROVIDENCE ROAD, 200 WEDDINGTON, NC 28207 (704) 321-0802

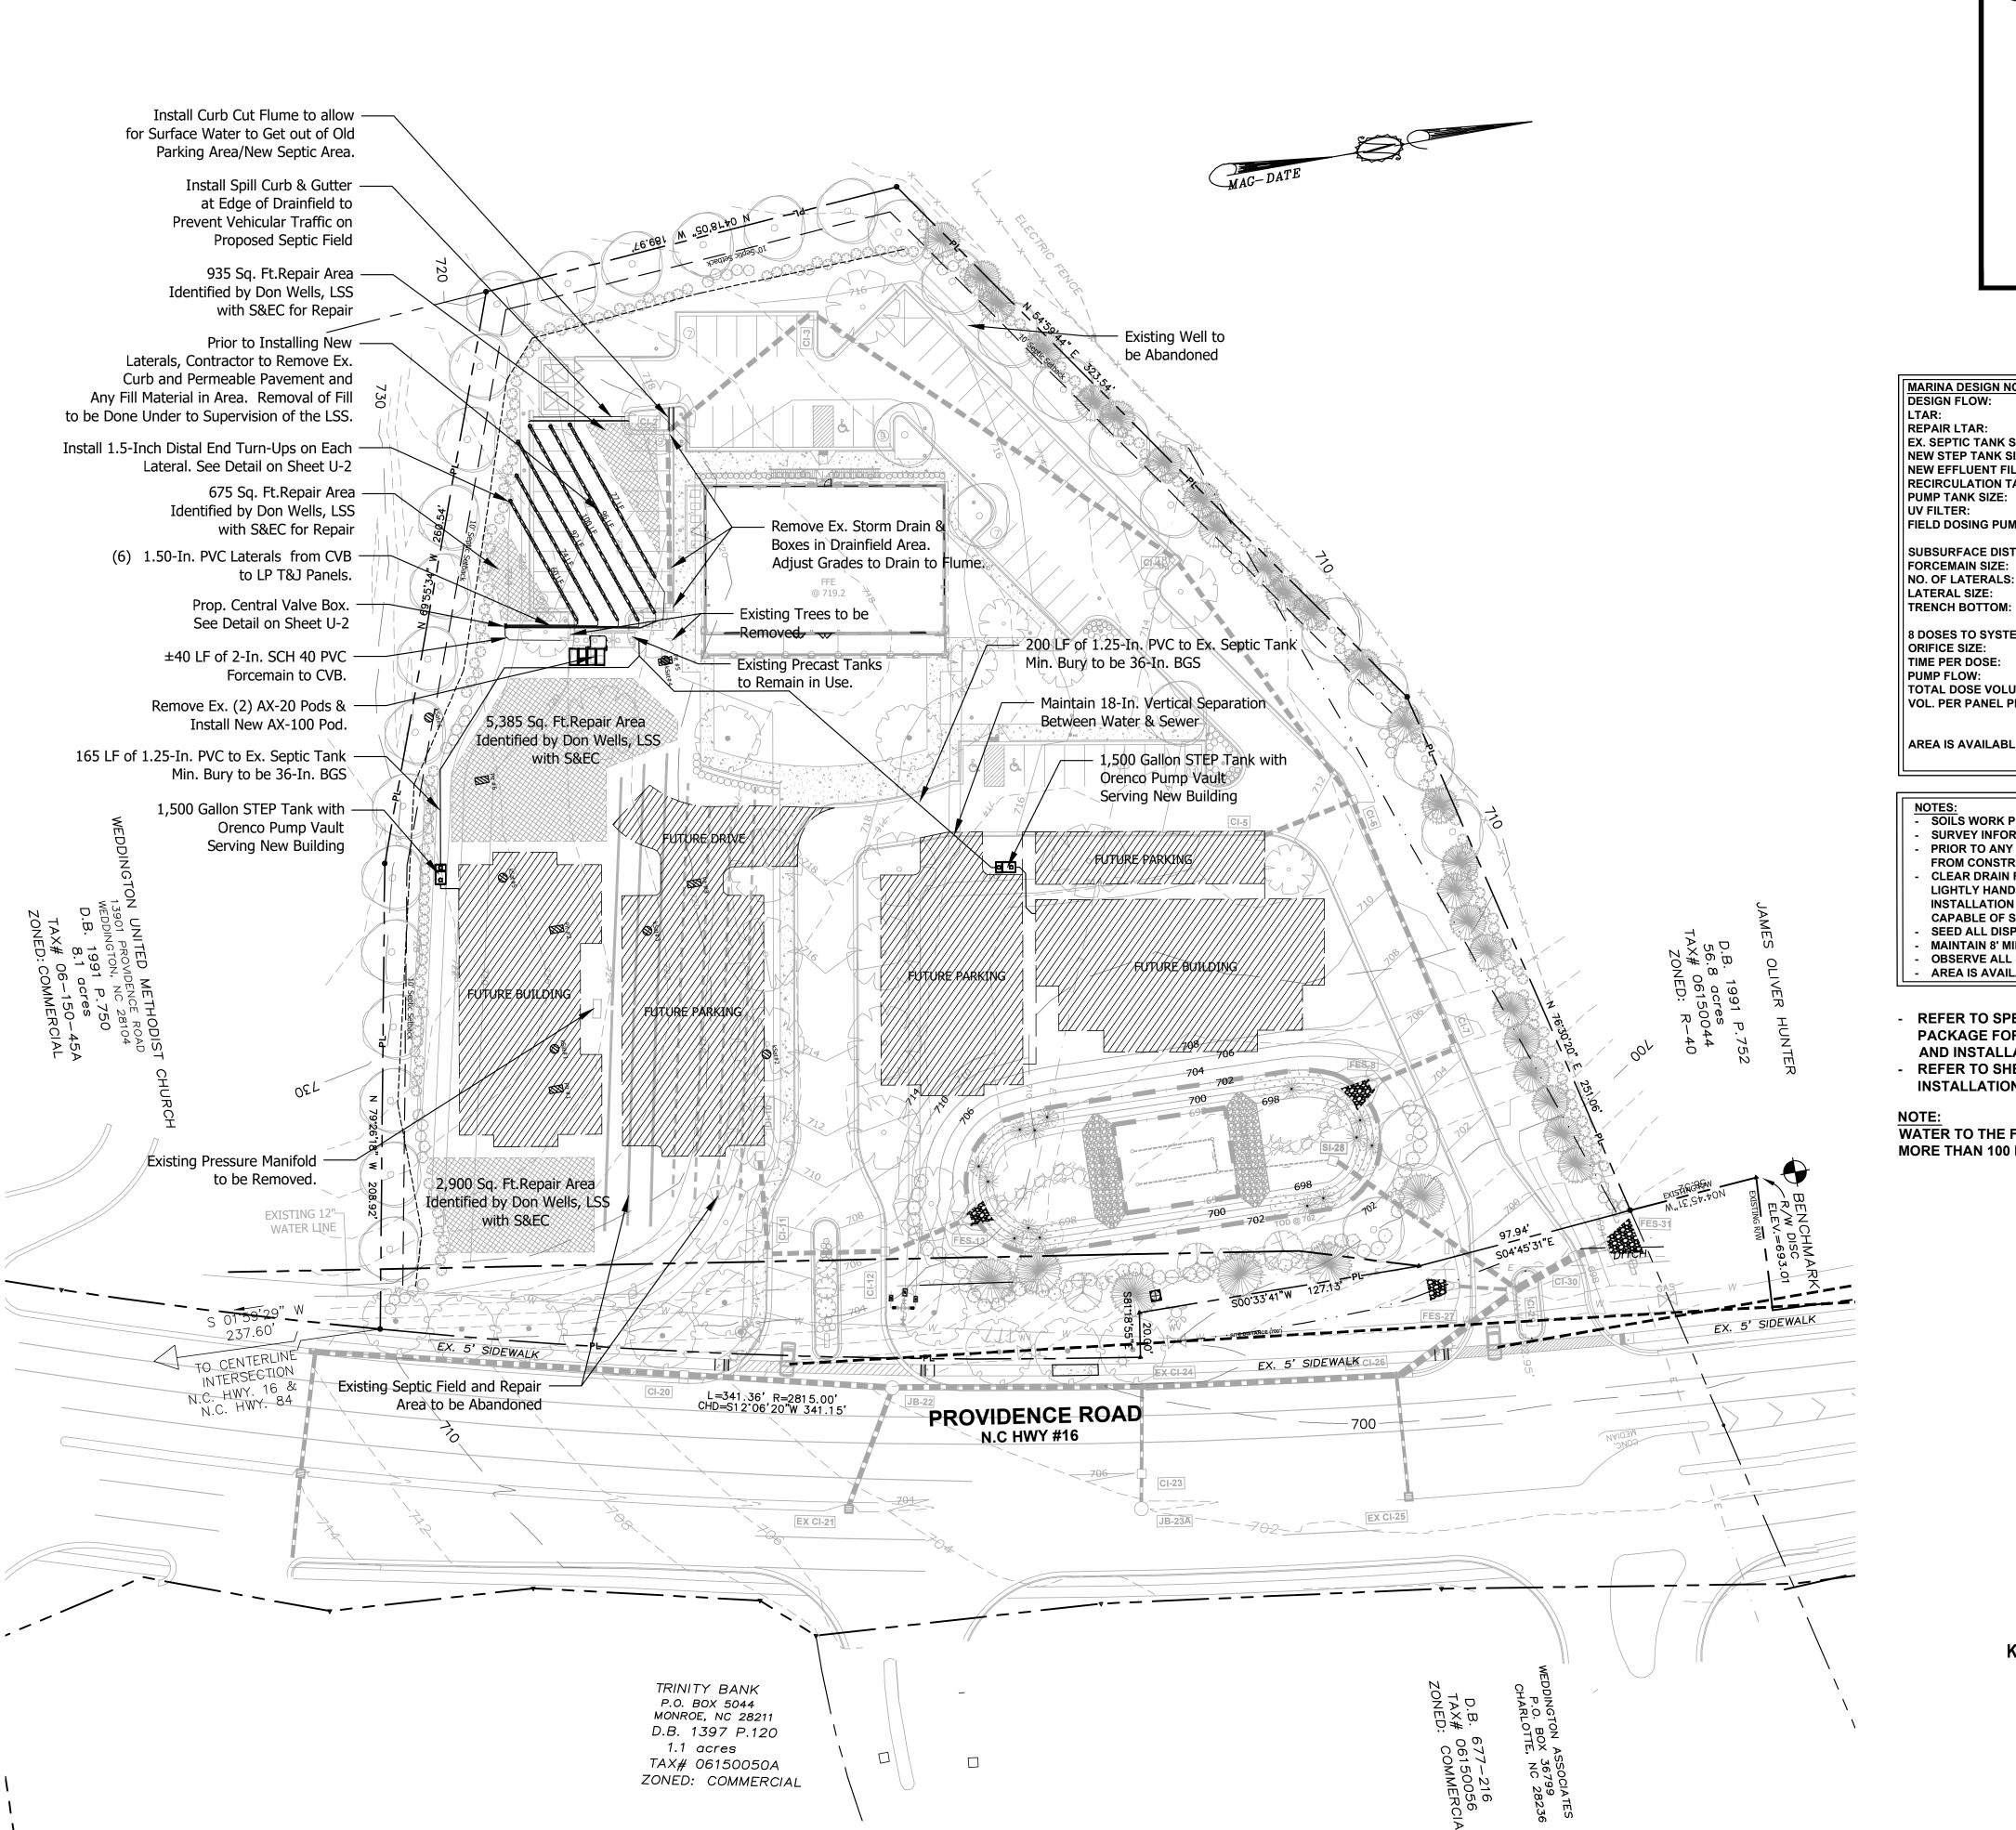

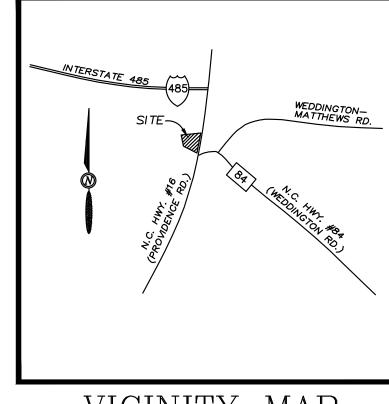

PIEDMONT

INTERNATIONAL Jence Road, suite 200 Ton, nc 28104 -321-0802

POLIVKA
13700 PROVID
WEDDING
704-

CAROLINA

E ROAL NORTH

OO PRO UNION

WEDDINGTON,

VICINITY MAP NO SCALE

MARINA DESIGN NOTES: DESIGN FLOW: REPAIR LTAR: EX. SEPTIC TANK SIZE: NEW STEP TANK SIZE: NEW EFFLUENT FILTER: RECIRCULATION TANK SIZE: PUMP TANK SIZE: UV FILTER:

0.55 G/D/SF (LP PPBPS) 2,000 GALLON (BAFFLED) (2) 1,500 GALLON STEP TANKS ORENCO MODEL **EX. 2,000 GALLON PRECAST TANK EX. 1,000 GALLON PRECAST TANK**

0.55 G/D/SF (LP PPBPS)

| FIELD DOSING PUMPS: ORENCO MODEL PF2005-12 SUBSURFACE DISTRIBUTION: FORCEMAIN SIZE:

LP PPBPS (VERITICAL) 2.0-INCH SCH 40 PVC 6 (VARIOUS LENGTHS) 1.5-INCH PR 160 PVC 48" PER DON WELLS, LSS

8 DOSES TO SYSTEM PER DAY **ORIFICE SIZE:** 1/8-INCH @ 3 FT HEAD TIME PER DOSE: 5.34 MINUTES PUMP FLOW: TOTAL DOSE VOLUME:

37.44 G/M 200 GAL./DOSE 1.71 GALLONS OR 47.48% OF VOL. PER PANEL PER DOSE: PANEL VOLUME

AREA IS AVAILABLE FOR REPAIR AND SHALL REMAIN UNDISTURBED

SOILS WORK PROVIDED BY DON WELLS, LSS WITH S&EC. SURVEY INFORMATION BY ISAACS GROUP.

- PRIOR TO ANY CONSTRUCTION, BARRICADE ALL DISPOSAL AREAS FROM CONSTRUCTION TRAFFIC
- CLEAR DRAIN FIELD OF ALL DEBRIS, LIMBS, ETC. LIGHTLY HAND SMOOTH ANY IRREGULAR SURFACES. REDO PRIOR TO INSTALLATION OF LATERALS, ENSURE THAT DISPOSAL AREAS ARE
- CAPABLE OF SHEDDING RAINWATER AND FREE OF ANY LOW AREAS SEED ALL DISPOSAL AREAS. MAINTAIN 8' MINIMUM SEPARATION ON ALL LATERALS
- OBSERVE ALL SETBACKS. AREA IS AVAILABLE FOR REPAIR AND SHALL REMAIN UNDISTURBED
- REFER TO SPECIFICATION **PACKAGE FOR MATERIALS SELECTION**
- AND INSTALLATION REQUIREMENTS REFER TO SHEET U-2 FOR TREATMENT PLAN/PROFILE, **INSTALLATION DETAILS & ELEVATIONS**

WATER TO THE FACILITY IS SERVED BY A WELL LOCATED MORE THAN 100 FEET FROM THE SYSTEM COMPONENTS.



Call before you dig.

GRAPHIC SCALE 1 inch = 30 feet

| Scale: 1, CONTOURS Drawn: DMD Checked: **DLM** Project: 2022-07-2 Job: 2022-07-2

1"=30 FT


Date: **11/02/222**


REVISIONS B


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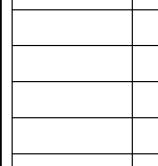
EXISTING DISCHARGE PIPE TO BE RE-ROUTED TO NEW CENTRAL VALVE BOX FOR LP PANELS. SEE DETAIL ON SHEET U-3

REPLACE EXISTING PUMP IN FINAL DOSING TANK WITH NEW PUMP CAPABLE OF PRODUCING 37.44 GPM AT 22.34 FT TDH



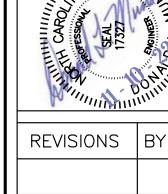

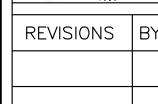


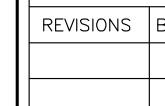



Date: 9,11/02/222 Scale: AS SHOWN Drawn: DMD

Checked: DLM Project: 2022-07-21 Job: 2022-07-21

U-2

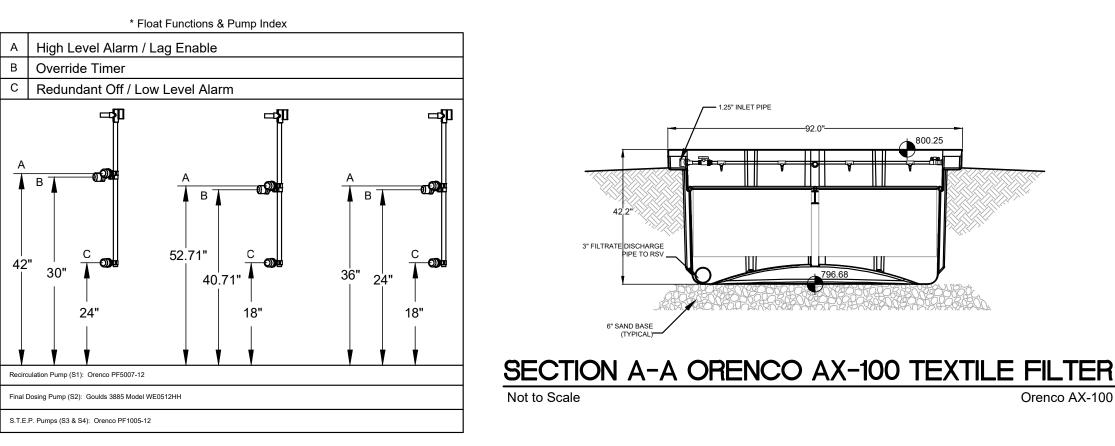

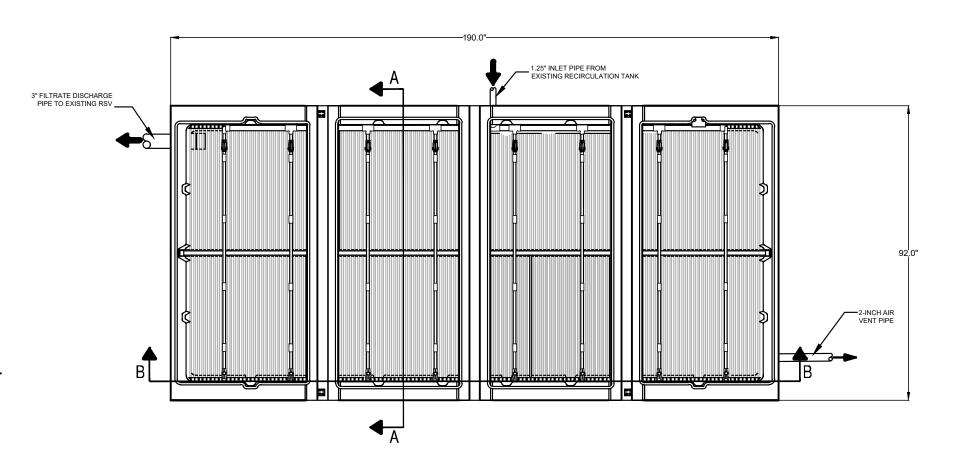

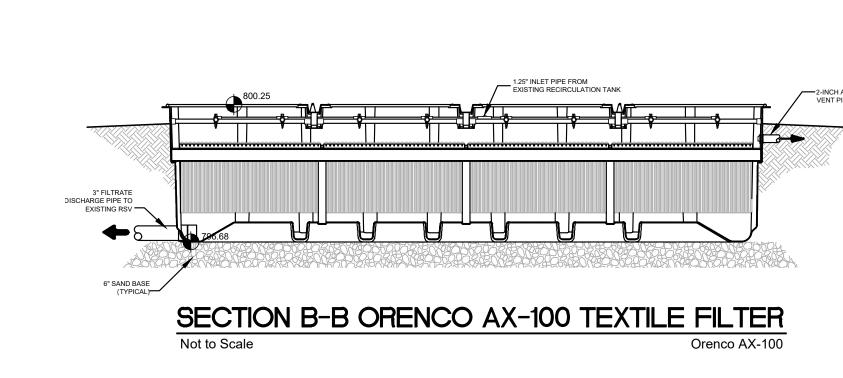


FLOAT SETTINGS Not to Scale


STB-360

Not to Scale

Not to Scale


PLAN VIEW-ORENCO AX-100 TEXTILE FILTER

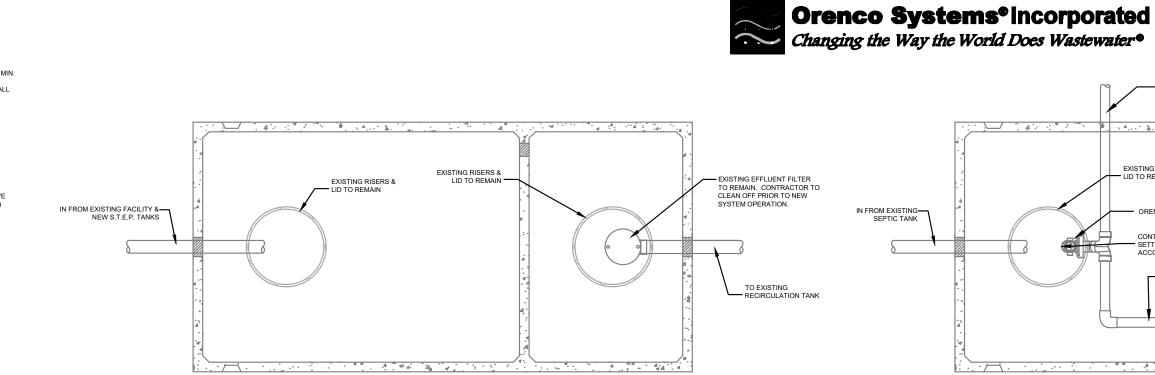


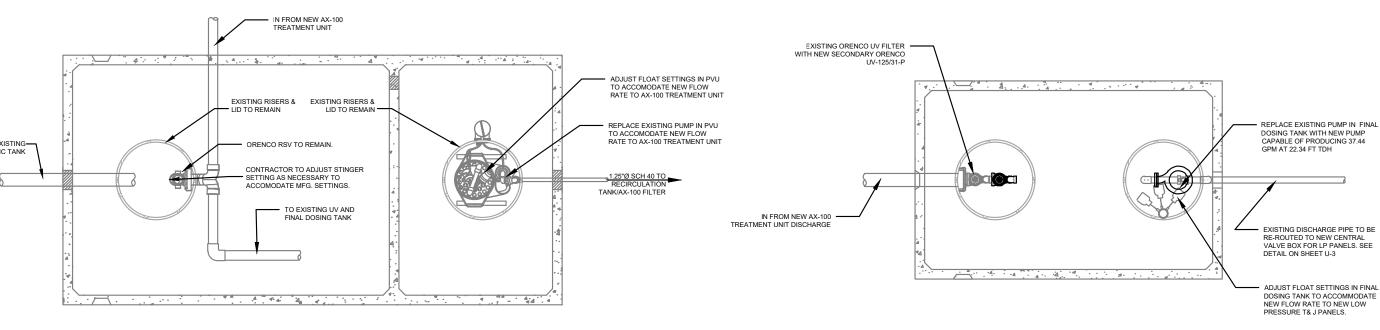

PLAN VIEW - 1,500 GALLON S.T.E.P. TANK


PLAN VIEW-EX. 2,000 GAL. SEPTIC TANK

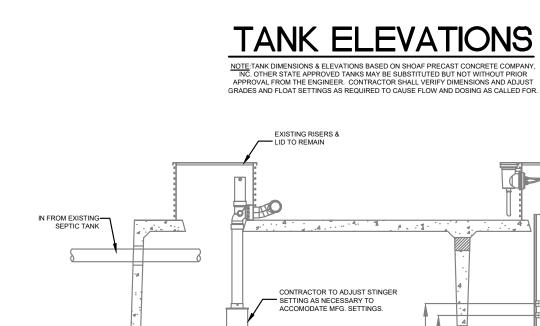


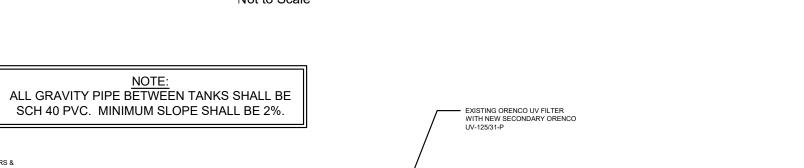

SECTION VIEW-EX. 1,000 GAL. PUMP TANK

PLAN VIEW-EX. 1,000 GAL. PUMP TANK

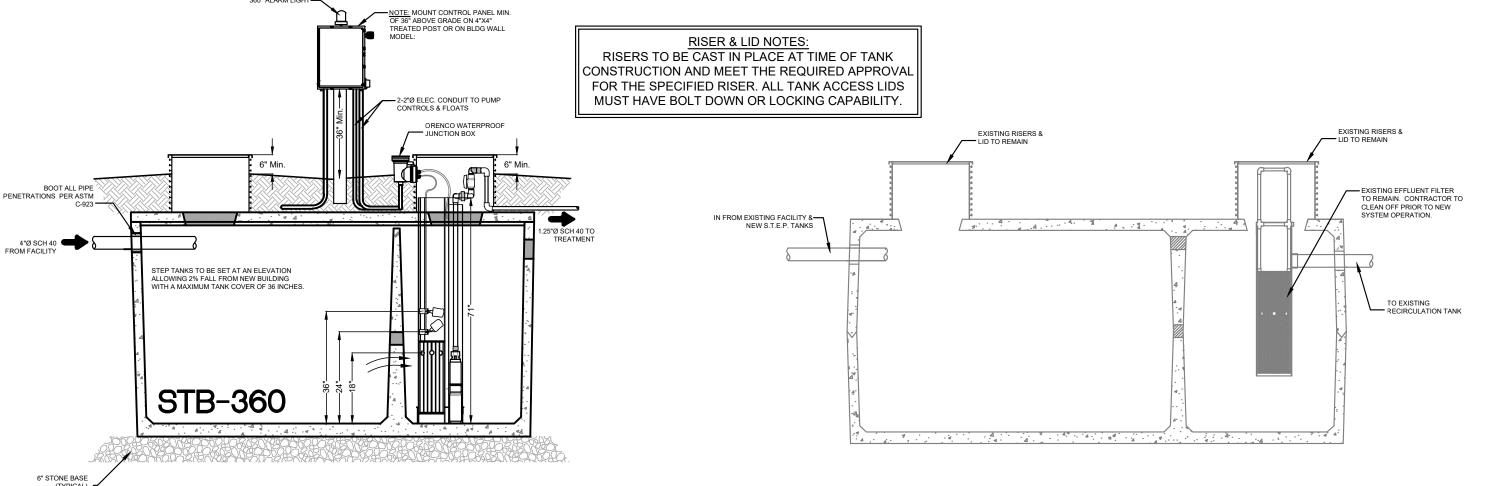

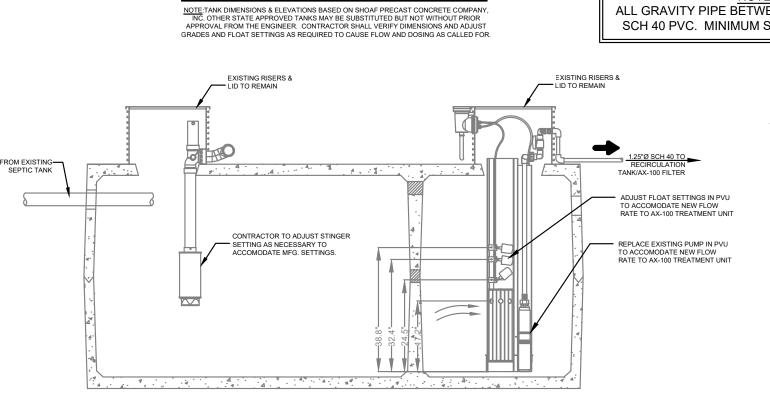

PLAN VIEW-EX. 2,000 GAL. RECIRC. TANK

Not to Scale

SECTION VIEW-EX. 2,000 GAL. SEPTIC TANK SECTION VIEW - 1,500 GALLON S.T.E.P. TANK Not to Scale


SECTION VIEW-EX. 2,000 GAL. RECIRC. TANK


PUBLICATION OR REUSE OF THESE DRAWINGS OR ANY DETAILS WITHIN MUST BE WITH THE WRITTEN CONSENT OF PIEDMONT DESIGN ASSOCIATES, P.A.


Drawn: DMD Checked: DLM Project: 2022-07-2

Job: 2022-07-2

U-3

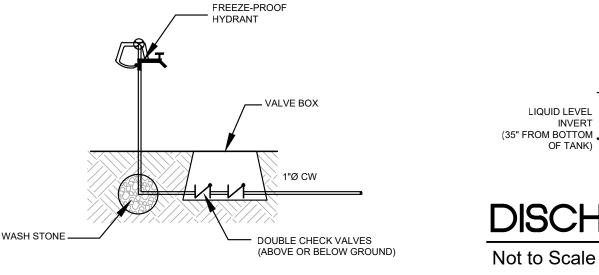


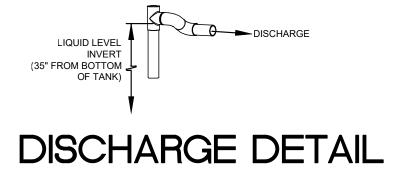

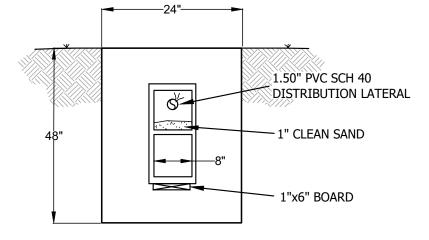

CUTAWAY OF PRESSURE PANEL



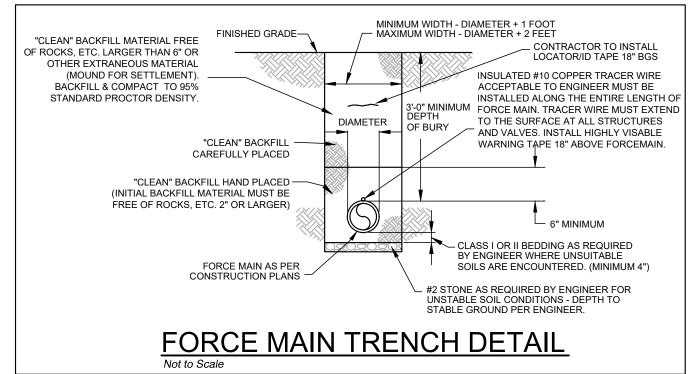


DAM TO ALLOW OVERFLOW SEAL ENTIRE 1.50" PVC SCH 40 TO FALL TO LOWER CHAMBERS CIRCUMFERENCE DISTRIBUTION LATERAL SEAL ONLY HALFWAY LOWER STORAGE AREAS

SANITARY SEWER (UNDER)

RELATION OF WATER MAINS

TO SANITARY SEWER MAINS

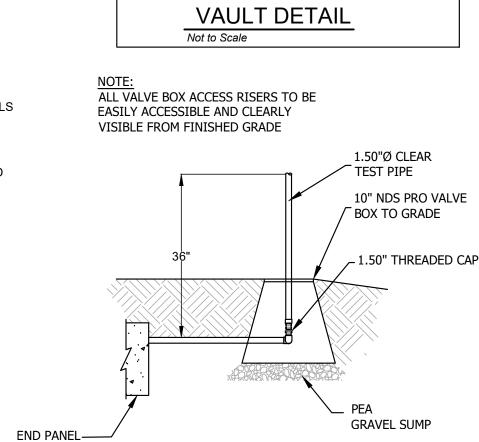

SIMPLEX PUMP

TURN UP DETAIL

TRENCH NOTES: I. 4" TYPICAL, 6" DEPTH IF IN ROCK

TANK WALL THICKNESS

PIPE PENETRATION DETAIL

PRECAST CONCRETE DONUT. SETUP SLIGHTLY ABOVE

GRADE TO PREVENT MOWER DAMAGE. GROUT INSIDE TO

PIPE SPOOL

SPOOL RISER

4"Ø PVC WYE

NOTE: ALL PVC FITTINGS SHOWN ARE SCH 40 RATED

Not to Scale

CLEANOUT DETAIL

3" x 1 1/2" ALUMINUM CHANNEL POST,

SET POST IN CONCRETE (2 REQ'D)

(SOCXSOCXSOC)

SLEEVE (OPTIONAL)

GROUT OR CAST IN PLACE (TYP)

PIPE SIZE SEE PLANS

Not to Scale

4"Ø PVC MALE CLEANOUT ADAPTOR

4"Ø SCH 40 PVC GRAVITY SEWER PIPE

36" TO BOTTOM

OF PANEL

Not to Scale

4"Ø PVC 45° ELBOW .

(SOCXSOC)

PANEL MOUNTING RISER

(SOCXFIPT) WITH PLUG (MIPT) OR EQUAL

PRESS-SEAL CAST-A-SEAL 402 RUBBER

TIGHTEN STRAF


STAINLESS STEEL PIPE STRAP


—FINISH GRADE (TYP)

(WATERTIGHT)

SLIDE PIPE INSIDE OF BOOT AND


- 2. FOUNDATION STONE REQUIRED WHEN SOIL CONDITIONS ARE UNSTABLE 3. CLEAR DISTANCE NOT LESS THAN 6" OR MORE THAN 12" ON EITHER SIDE
- 4. INITIAL BACKFILL SHALL BE PLACED IN 6" LIFTS AND COMPACTED. INITAL BACKFILL SHALL
- CONTAIN NO BACKFILL OVER 1.5", FROZEN LUMPS OR DEBRIS. 5. BACKFILL SHALL BE COMPACTED TO 95% STANDARD PROCTOR DENSITY
- 6. PVC PIPE SHALL BE SCH 40 PVC
- 7. DETAIL SHALL BE USED FOR ALL TRANSPORT PIPING TO AND FROM DISPOSAL AREA 8. SEE DETAIL FOR DUCTILE SLEEVE UNDER STREAM ON PLAN SHEET U-3

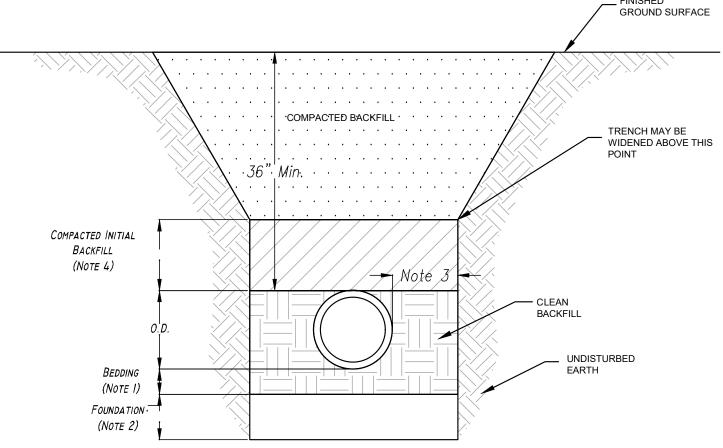


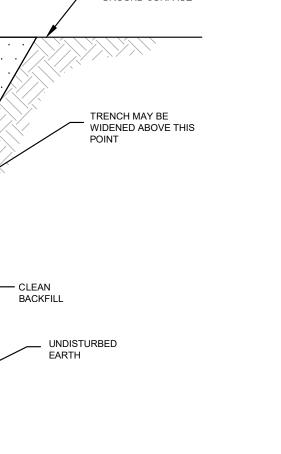


PVC SEWER PIPE BEDDING DETAIL

Not to Scale

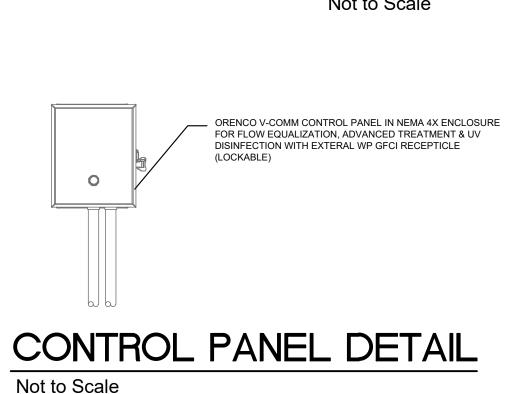

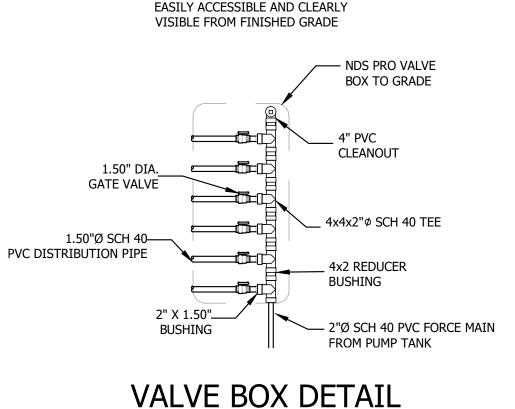

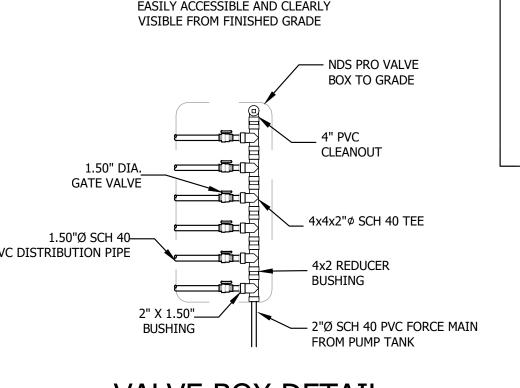

WHEN THE WATER MAIN IS ABOVE THE SANITARY SEWER, BUT WITH LESS THAN 18" CLEARANCE, OR WHEN THE ALL VALVE BOX ACCESS RISERS TO BE SANITARY SEWER IS ABOVE THE WATER MAIN, BOTH THE WATER MAIN AND THE SANITARY SEWER LINE SHALL BE EASILY ACCESSIBLE AND CLEARLY CONSTRUCTED OF DUCTILE IRON PIPE WITH JOINTS EQUIVALENT TO WATER MAIN STANDARDS FOR A MINIMUM LATERAL DISTANCE, MEASURED AT RIGHT ANGLES TO THE SEWER, OF 10 FEET ON EACH SIDE

GENERAL NOTES

NOTIFY UNDERGROUND UTILITIES LOCATOR PRIOR TO ANY EXCAVATION. CONTRACTOR IS RESPONSIBLE FOR COORDINATION OF ALL TRADES AND SUBCONTRACTORS. CONTRACTOR IS RESPONSIBLE FOR FIELD VERIFYING ALL DIMENSIONS, ELEVATIONS, AND LOCATION OF ALL EXISTING **CONDITIONS AND UTILITIES**

HOSE AND VALVE

ASSEMBLY

CHECK VALVE

FLOAT ASSEMBLY

- BIOTUBE CARTRIDGE

HIGH HEAD PUMP

- ALL PIPING SHALL BE SCH 40 PVC UNLESS OTHERWISE NOTED ON PLANS. ALL PVC PIPES SHALL BE BURIED A MINIMUM OF 3 FEET UNLESS SHOWN OTHERWISE.
- CONTRACTOR SHALL COMPLY WLTH ALL APPLICABLE SOIL EROSION AND SEDIMENTATION CONTROL REQUIREMENTS.
- CONTRACTOR SHALL COMPLY WLTH ALL APPLICABLE OSHA, NCDOT, AND OTHER RELATED SAFETY REQUIREMENTS.
- CONTRACTOR SHALL BE RESPONSIBLE FOR REPAIRING ALL CONSTRUCTION DAMAGE EXPEDITIOUSLY AND AT NO ADDITIONAL COST TO
- SEPTIC TANKS SHALL BE CONSTRUCTED WITH A BAFFLE WALL DIVIDING THE TANK INTERIOR 2/3rd TO 1/3rd. THE BAFFLE WALL SHALL BE CONSTRUCTED TO PERMIT PASSAGE OF EFFLUENT THROUGH A SLOT OR HOLES LOCATED BETWEEN 45 & 55 PERCENT OF THE INTERIOR DEPTH
- ALL TANKS SHALL HAVE A MINIMUM 28-DAY CONCRETE STRENGTH OF 4,500
- TANKS SHALL MEET REINFORCING REQUIREMENTS TO ACCOMMODATE 3,000 POUNDS PER SQ. FT. EITHER STEEL REINFORCING WIRE. REBAR OR APPROVED FIBER MAY BE USED.
- ALL SERVICE ACCESS OPENINGS WILL BE A MINIMUM OF 24 INCHES. ALL TANKS AND EFFLUENT FILTERS SHALL BE APPROVED BY ENGINEER. EFFLUENT FILTERS SHALL BE SIZED FOR DESIGN FLOW AND EXTEND DOWN TO 50-PERCENT OF LIQUID LEVEL
- ALL JOINTS (MID-SEAM, TOP-SEAM) SHALL BE SEALED USING CONCRETE SEALANTS BUTYL SEALANT # CS-102 MEETING ASTM C-990.
- TANKS SHALL BE LEAK-TESTED PRIOR TO SYSTEM START UP BY APPLYNG A VACUUM OF 5-INCHES OF MERCURY WITH RISER ASSEMBLIES IN PLACE OR WITH APPROVAL BY ENGINEER. A 24-HOUR STATIC WATER TEST IN ACCORDANCE WITH ASTM STANDARDS
- ALL PIPE PENETRATIONS THROUGH PRECAST CONCRETE TANKS SHALL
- BE PRESS-SEAL CAST-A-SEAL 402 RUBBER BOOTS AND GROUTED
- ALL TANK RISERS AND LIDS SHALL BE A MINIMUM OF 6" ABOVE THE FINISHED GRADE
- ALL METAL INSTALLED IN TANKS SHALL BE STAINLESS STEEL.
- ALL MANHOLES NOT INSTALLED NOT IN TRAFFIC AREAS SHALL HAVE BOLT DOWN LIDS. LIDS SHALL BE 6" MINIMUM ABOVE FINISHED GRADE
- CONTROL PANELS SHALL BE INSTALLED A MINIMUM OF 36 INCHES FROM FINISHED GRADE TO BOTTOM OF PANEL BOX. SEAL OFF ALL CONDUITS BETWEEN TANKS AND PANEL.

REVISED 1-22-01